

MIAMI-DADE COUNTY PRODUCT CONTROL SECTION

11805 SW 26 Street, Room 208 T (786) 315-2590 F (786) 315-2599

www.miamidade.gov/economy

DEPARTMENT OF REGULATORY AND ECONOMIC RESOURCES (RER) BOARD AND CODE ADMINISTRATION DIVISION

NOTICE OF ACCEPTANCE (NOA)

Peetz Windows and Doors, Inc. 15951 SW 41st Street, Suite 150 Weston, FL 33331

SCOPE:

This NOA is being issued under the applicable rules and regulations governing the use of construction materials. The documentation submitted has been reviewed and accepted by Miami-Dade County RER - Product Control Section to be used in Miami Dade County and other areas where allowed by the Authority Having Jurisdiction (AHJ).

This NOA shall not be valid after the expiration date stated below. The Miami-Dade County Product Control Section (In Miami Dade County) and/or the AHJ (in areas other than Miami Dade County) reserve the right to have this product or material tested for quality assurance purposes. If this product or material fails to perform in the accepted manner, the manufacturer will incur the expense of such testing and the AHJ may immediately revoke, modify, or suspend the use of such product or material within their jurisdiction. RER reserves the right to revoke this acceptance, if it is determined by Miami-Dade County Product Control Section that this product or material fails to meet the requirements of the applicable building code.

This product is approved as described herein, and has been designed to comply with the Florida Building Code, including the High Velocity Hurricane Zone.

DESCRIPTION: Series "American" Bronze Clad Outswing Wood Door – L.M.I.

APPROVAL DOCUMENT: Drawing No. **1688**, titled "American Out-Swing Bronze Clad Impact Wood Doors", sheets 1 through 8 of 8, dated 07/05/12, prepared by W.W. Schaefer Engineering & Consulting, P.A., signed and sealed by Warren W. Schaefer, P.E., bearing the Miami-Dade County Product Control Approval stamp with the Notice of Acceptance number and approval date by the Miami-Dade County Product Control Section.

MISSILE IMPACT RATING: Large and Small Missile Impact Resistant

LIMITATION: Optional ADA threshold does not meet the water requirement, see Sill Detail and note on Sheet 6 of 8.

LABELING: Each unit shall bear a permanent label with the manufacturer's name or logo, city, state, model/series, and following statement: "Miami-Dade County Product Control Approved", unless otherwise noted herein.

RENEWAL of this NOA shall be considered after a renewal application has been filed and there has been no change in the applicable building code negatively affecting the performance of this product.

TERMINATION of this NOA will occur after the expiration date or if there has been a revision or change in the materials, use, and/or manufacture of the product or process. Misuse of this NOA as an endorsement of any product, for sales, advertising or any other purposes shall automatically terminate this NOA. Failure to comply with any section of this NOA shall be cause for termination and removal of NOA.

ADVERTISEMENT: The NOA number preceded by the words Miami-Dade County, Florida, and followed by the expiration date may be displayed in advertising literature. If any portion of the NOA is displayed, then it shall be done in its entirety.

INSPECTION: A copy of this entire NOA shall be provided to the user by the manufacturer or its distributors and shall be available for inspection at the job site at the request of the Building Official.

This NOA consists of this page 1 and evidence pages E-1 and E-2, as well as approval document mentioned above.

The submitted documentation was reviewed by Manuel Perez, P.E.

MIAMI-DADE COUNTY
APPROVED

NOA No. 12-0713.04 Expiration Date: October25, 2017 Approval Date: October25, 2012 Page 1

Peetz Windows and Doors, Inc.

NOTICE OF ACCEPTANCE: EVIDENCE SUBMITTED

A. DRAWINGS

- 1. Manufacturer's die drawings and sections.
- 2. Drawing No. 1688, titled "American Out-Swing Bronze Clad Impact Wood Doors" sheets 1 through 8 of 8, dated 07/05/12, prepared by W.W. Schaefer Engineering & Consulting, P.A., signed and sealed by Warren W. Schaefer, P.E.

B. TESTS

- 1. Test reports on: 1) Air Infiltration Test, per FBC, TAS 202-94
 - 2) Uniform Static Air Pressure Test, Loading per FBC TAS 202-94
 - 3) Water Resistance Test, per FBC, TAS 202-94
 - 4) Large Missile Impact Test per FBC, TAS 201-94
 - 5) Cyclic Wind Pressure Loading per FBC, TAS 203-94
 - 6) Forced Entry Test, per FBC 2411 3.2.1, TAS 202-94

along with marked-up drawings and installation diagram of an series American outswing bronze clad wood casement windows & doors, prepared by Hurricane National Test Laboratory LLC, Test Report No. **HTL-0284-0501-10B**, dated 09/13-15/12, signed and sealed by Vinu J. Abraham, P.E.

C. CALCULATIONS

- 1. Anchor verification calculations and structural analysis, complying with FBC-2010, dated 12/14/11, prepared by W.W. Schaefer Engineering & Consulting, P.A., signed and sealed by Warren W. Schaefer, P.E.
- 2. Glazing complies with ASTM E1300-04

D. QUALITY ASSURANCE

1. Miami-Dade Department of Regulatory and Economic Resources (RER)

E. MATERIAL CERTIFICATIONS

1. Notice of Acceptance No. 11–1102.09 issued to Solutia, Inc. for their "Saflex CP – Saflex and Saflex HP Composites Glass Interlayers with PET Core" dated 06/14/12, expiring on 12/11/13.

Manuel Perez, P.E. Product Control Examiner

NOA No. 12-0713.04 Expiration Date: October25, 2017

Approval Date: October 25, 2017

Approval Date: October 25, 2012

Peetz Windows and Doors, Inc.

NOTICE OF ACCEPTANCE: EVIDENCE SUBMITTED

F. STATEMENTS

- 1. Statement letter of conformance, complying with FBC-2010, dated December 10 2011, issued W.W. Schaefer Engineering & Consulting, P.A., signed and sealed by Warren W. Schaefer, P.E.
- 2. Statement letter of no financial interest, issued by Al–Farooq Corporation, dated December 13, 2011, prepared by W.W. Schaefer Engineering & Consulting, P.A., signed and sealed by Warren W. Schaefer, P.E.
- 3. Laboratory compliance letter for Test Report No. HTL-0284-0501-10B, issued by Hurricane Test Laboratory, LLC, dated November 14, 2011, signed and sealed by Vinu J. Abraham, P. E.
- 4. Distributor Agreement between Helmut Peetz GMBH., Kall, Germany and Peetz Windows and Doors, Inc., Florida USA, dated 07/06/12, signed by Christian Peetz and Eva Marie Leon, respectively.
- 5. Proposal No. **09–1388** issued by Product Control, revised on 05/14/08 and again on. March 19, 2012, signed by Jaime Gascon, P.E.

G. OTHER

1. None.

Manuel Peres, P.E.
Product Control Examiner
NOA No. 12-0713.04

Expiration Date: October 25, 2017 Approval Date: October 25, 2012

GENERAL NOTES: THESE DOOR SYSTEMS HAVE BEEN TESTED, ANALYZED & APPROVED FOR DESIGN PRESSURES NOT 77" MAX. FRAME WIDTH TO EXCEED THOSE SHOWN IN THE "ALLOWABLE DESIGN PRESSURE TABLE(S)" 2. OPENINGS, BUCKING & BUCKING FASTENERS MUST BE PROPERLY DESIGNED & INSTALLED TO т., 6", 6", гт. 3" ТО 5' TRANSFER WIND LOADS TO THE STRUCTURE. 3. ALL HARDWARE & FASTENERS SHALL BE IN ACCORDANCE WITH THESE DRAWINGS & SHALL NOT 6" MAX. — 6" MAX. VARY UNLESS SPECIFICALLY MENTIONED ON THE DRAWINGS. SPECIFIED ANCHOR EMBED TO BASE MATERIAL SHALL BE BEYOND WALL FINISH OR STUCCO. 4. THE DETAILS & SPECIFICATIONS SHOWN HEREIN REPRESENT THE PRODUCTS TESTED & PROPOSED FOR WATER, AIR, IMPACT, CYCLIC & UNIFORM STATIC AIR PRESSURE TESTING IN CONFORMANCE WITH 6" MAX. THE FLORIDA BUILDING CODE PROTOCALS TAS-201, 202 & 203 FOR LARGE MISSILE IMPACT DOORS. THESE DOOR SYSTEMS HAVE BEEN DESIGNED IN ACCORDANCE WITH AND MEET THE REQUIREMENTS (31)OF THE FLORIDA BUILDING CODE (FBC) INCLUDING HIGH VELOCITY HURRICANE ZONES (HVHZ). HINGE IMPACT SHUTTERS ARE NOT REQUIRED WITH THESE DOORS. ALL ANCHORS SECURING DOOR FRAME TO PRESSURE TREATED BUCKS OR WOOD FRAMING SHALL BE CAPABLE OF RESISTING CORROSION CAUSED BY THE PRESSURE TREATING CHEMICALS IN THE WOOD. DETERMINE THE POSITIVE & NEGATIVE DESIGN LOADS TO USE WHEN REFERENCING THESE DOCUMENTS IN ACCORDANCE WITH THE GOVERNING CODE AND GOVERNING WIND VELOCITY. FOR WIND LOAD CALCULATIONS IN ACCORDANCE WITH THE FLORIDA BUILDING CODE, A DIRECTIONALITY FACTOR OF **INACTIVE ACTIVE** KD = 0.85 MAY BE APPLIED PER THE ASCE-7 STANDARD. 9. NO INCREASE IN ALLOWABLE STRESS HAS BEEN USED IN THE CERTIFICATION OF THIS PRODUCT. WIND LOAD DURATION FACTOR CD = 1.6 WAS USED FOR WOOD SCREW ANALYSIS ONLY. 10. MATERIALS, INCLUDING BUT NOT LIMITED TO STEEL SCREWS, THAT COME INTO CONTACT WITH OTHER **OPPOSITE** DISSIMILAR MATERIALS SHALL MEET THE REQUIREMENTS OF FLORIDA BUILDING CODE CHAPTER 20. 11. ALL WOOD MEMBERS OF DOORS THAT MAY POSSIBLY COME INTO CONTACT WITH MASONRY OR HEIGHT 4 CONCRETE SUBSTRATES, ARE SUBJECT TO MOISTURE &/OR ARE SUBJECT TO THE OUTSIDE ENVIRONMENT SHALL BE OF AN APPROVED DURABLE SPECIES OR BE TREATED IN AN APPROVED <u>ا</u>. METHOD WITH AN APPROVED PRESERVATIVE PER FBC SECTION 2326. MAX. **CORNER CONSTRUCTION:** RECTANGULAR FRAME: COPED, BUTTED TOGETHER, JOINED WITH 2 NO. 10 X 3 1/8" SCREWS & GLUED WITH BINDAN D4 OR EQUAL. SHAPED FRAME: MEMBER ARE GROOVED, BUTTED TOGETHER, JOINED WITH 2 MAHOGANY TONGUES & GLUED WITH BINDAN D4 OR EQUAL. RECTANGULAR PANEL: MULTI-FORKED, BUTTED & GLUED WITH BINDAN D4 OR EQUAL ALTERNATE BOTTOM RAIL: COPED, BUTTED TO STILES, JOINED WITH TEN(10) 3/8" X 3 1/8" WOOD DOWELS & GLUED WITH BINDAN D4 OR EQUAL SHAPED PANEL: MULTI-FORKED, BUTTED & GLUED WITH BINDAN D4 OR EQUAL. MID-RAIL ENDS: COPED, BUTTED TO STILES/RAILS, JOINED WITH TWO(2) 3/8" X 3 1/8" WOOD DOWELS & GLUED WITH BINDAN D4 OR EQUAL. HANDLE FRAME CLAD: MEMBERS ARE MITERED TOGETHER & WELDED ON THE EXTERIOR SIDE. PANEL CLAD: MEMBERS ARE MITERED TOGETHER & WELDED TOGETHER ON THE INTERIOR SIDE. 31" MAX. D.L.O. SEE "CORNER-CONSTRUCTION" **EXTERIOR ELEVATION:** DESCRIPTION ON

| FRAME ANCHOR REQUIREMENTS TABLE | | | | | | |
|---|---|------------------|-----------------------|--|--|--|
| OPENING TYPE (SUBSTRATE) | FRAME/CLIP TO OPENING FASTENER TYPE | MINIMUM EMBED | MINIMUM EDGE DIST. | | | |
| FRAME SCREWS | | | | | | |
| MIN. 2X4 WOOD FRAME OR BUCK (MIN. GR. 3 & G=0.55) | NO. 14 SMS OR WOOD SCREW | 1 1/4" | 3/4" | | | |
| MIN. 16 GA. 33 KSI METAL STUD | 1/4" GR. 5 SELF TAP/DRILL SCREW | FULL | 1/2" | | | |
| MIN. 1/8" THK A36 STEEL | 1/4" GR. 5 SELF TAP/DRILL SCREW | FULL | 1/2" | | | |
| MIN. 1/8" THK 6063-T5 ALUM. | 1/4" GR. 5 SELF TAP/DRILL SCREW | FULL | 1/2" | | | |
| (2) MIN. C-90 CMU | (1) 1/4" CONCRETE SCREW | 1 1/4" | 2 1/2" | | | |
| MIN. 2500 PSI CONCRETE | (1) 1/4" CONCRETE SCREW | 1 1/2" | 2 1/2" | | | |
| ANGLE CLIP INSTALLATION SCREWS | | | | | | |
| MIN. 2X4 WOOD FRAME OR BUCK (MIN. GR. 3 & G=0.55) | NO. 8 SMS SCREW | 1 3/8" | 1/2" | | | |
| MIN. 1/8" THK A36 STEEL | NO. 8 GR. 5 SELF TAP/DRILL SCREW | FULL | 1/2" | | | |
| MIN. 1/8" THK 6063-T5 ALUM. | NO. 8 GR. 5 SELF TAP/DRILL SCREW | FULL | 1/2" | | | |
| NARROW INSTALLATION BRACKET SCREWS | | | | | | |
| MIN. 2X6 WOOD FRAME OR BUCK (MIN. GR. 3 & G=0.55) | NO. 8 SMS SCREW | 1 3/8" | 3/4" | | | |
| MIN. 16 GA. 33 KSI METAL STUD | NO. 8 GR. 5 SELF TAP/DRILL SCREW | FULL | 1/2" | | | |
| MIN. 1/8" THK A36 STEEL | NO. 8 GR. 5 SELF TAP/DRILL SCREW | FULL | 1/2" | | | |
| MIN. 1/8" THK 6063-T5 ALUM. | NO. 8 GR. 5 SELF TAP/DRILL SCREW | FULL | 1/2" | | | |
| WIDE INSTALLATION BRACKET SCREWS | | | | | | |
| MIN. 2X6 WOOD FRAME OR BUCK (MIN. GR. 3 & G=0.55) | NO. 8 SMS SCREW | 1 3/8" | 3/4" | | | |
| MIN. 16 GA. 33 KSI METAL STUD | NO. 8 GR. 5 SELF TAP/DRILL SCREW | FULL | 1/2" | | | |
| MIN. 1/8" THK A36 STEEL | NO. 8 GR. 5 SELF TAP/DRILL SCREW | FULL | 1/2" | | | |
| MIN. 1/8" THK 6063-T5 ALUM. | NO. 8 GR. 5 SELF TAP/DRILL SCREW | FULL | 1/2" | | | |
| (2) MIN. C-90 CMU | (1) 3/16" CONCRETE SCREW | 1 1/4" | 2" | | | |
| MIN. 2500 PSI CONCRETE | (1) 3/16" CONCRETE SCREW | 1 1/2" | 2" | | | |
| RAMSET/RED HEAD TAPCONS (C. | LCO ULTRACONS (C.S.), ELCO CRETE-FLI S. OR S.S.) OR HILTI KWIK-CON II (C.S NLY (NOT APPLICABLE AT HEAD OR SILL) | OR S.S.) | ITW | | | |

HEIGHT D.L.0. ON THIS SHEET FOR **ANCHOR** # DOORS
TYREET; SUITE
1, 33331
-3887 REQUIREMENTS. REQUIREMENTS 3534 LOCK MAX. TABLE" ON THIS WOOD SHEET FOR HORIZONTAL SASH BAR REQUIREMENTS. WINDOWS & 41ST STREET APPLICABLE WITH ALL **IMPACT** DOOR PANELS (MAY 123 USE MULTIPLE HORIZONTAL BARS IN ONE DOOR PANEL CLAD HANDLE BRONZE 15" MAX. O.C. 15" MAX. O.C. 31 (AT SIDES) (AT SIDES) MAX. D.L.O. SWING TANTS
SCHAEFER ENGINEERING
C CONSULTING, P.A. 5 6" MAX 6" MAX. **EXTERIOR ELEVATION:** SINGLE RECTANGULAR DOOR DOUBLE RECTANGULAR DOOR THIS SHEET SCALE: 1/2" = 1'-0"SCALE: 1/2" = 1'-0"ALLOWABLE DESIGN PRESSURE (ALL DOORS CONDITIONS) +/-70 PSF 2012 HINGE TABLE Approved as complying with the Florida Building Code
Date OCT. 25, 2012
NOA# 12-0713.04 HINGE REQUIREMENTS DOOR SHAPE CENTERLINE OF HINGES SHALL BE HALF-ROUND LOCATED 8" FROM BOTTOM OF DOOR TOP PANEL, 2 3/4" FROM SPRINGLINE AND MAX. 28 1/2" O.C. BETWEEN. CENTERLINE OF HINGES SHALL BE THESE DRAWINGS ARE APPLICABLE ONLY TO THE PRODUC SPECIFIED. THEY MAY NOT BE USED FOR THE ASSEMBLY LOCATED 8" FROM TOP & BOTTOM ALL OTHER 1688 AND/OR INSTALLATION OF ANY OTHER PRODUCT NOR MAY OF DOOR PANEL CORNERS AND MAX. SHAPES SHEET NO. THEY BE USED FOR RATIONAL AND/OR LOCAL APPROVAL F ANY PRODUCT NOT PRODUCED BY THE MANUFACTURES TATED ON THESE DRAWINGS. 28 1/2" O.C. BETWEEN. **1** OF

FRAME/SILL SCREWS,

SHOWN. SEE "FRAME

REQUIREMENTS TABLE"

ANGLE CLIPS OR

BRACKETS WHERE

INSTALLATION

ANCHOR

CHECKED BY

W.W.S.

07/05/12

W.R.M.

1=24

39 7/8" MAX.

FRAME WIDTH

HINGE

6" MAX. —

4

SIMILAR

 $\frac{A}{3}$

5

6" MAX.

6" MAX.

-FRAME/SILL

CLIPS OR


BRACKETS


INSTALLATION


SEE "FRAME


WHERE SHOWN.


SCREWS, ANGLE

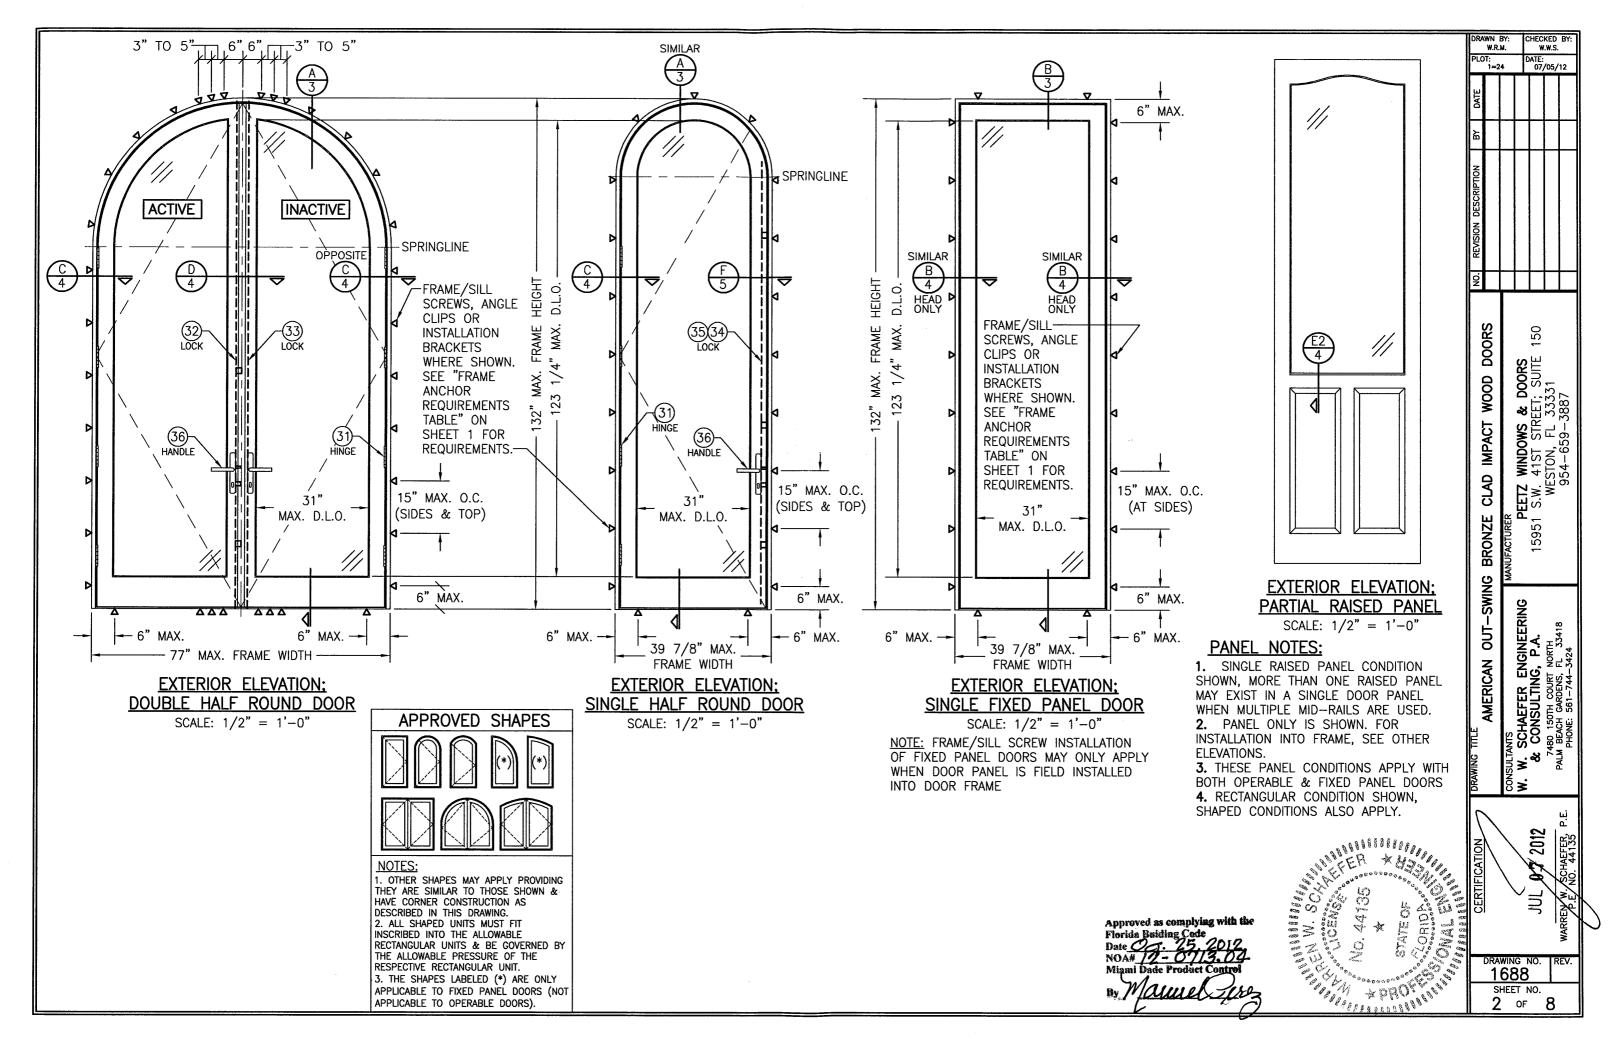


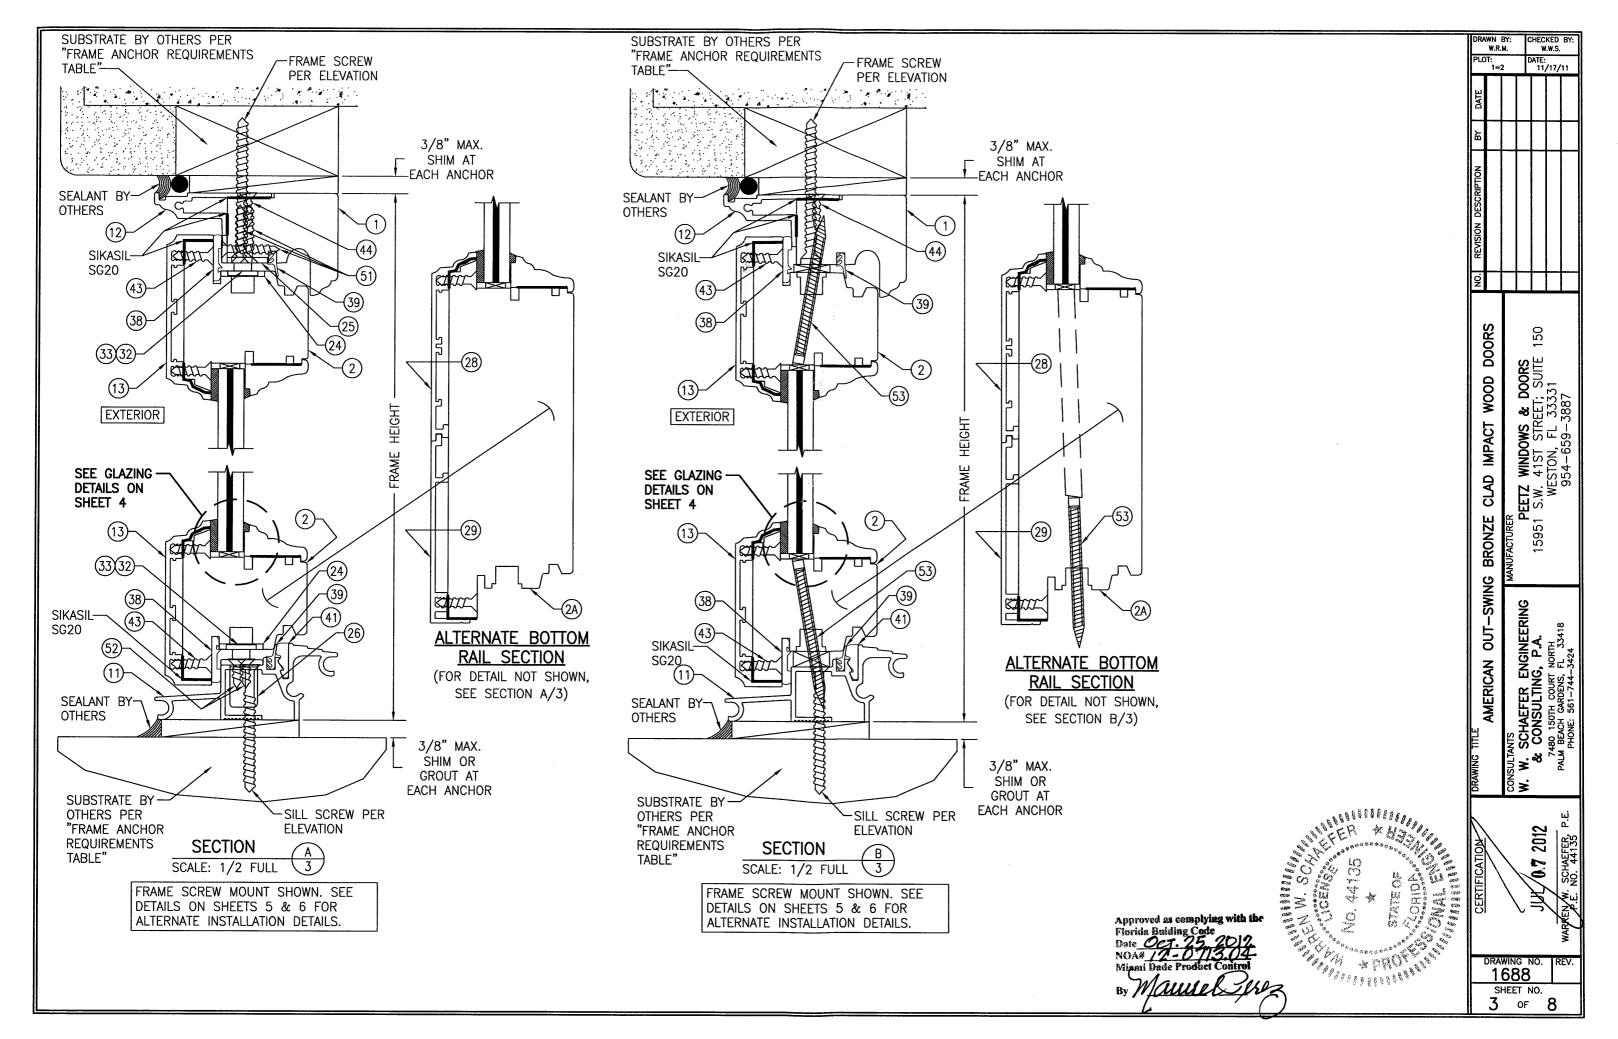

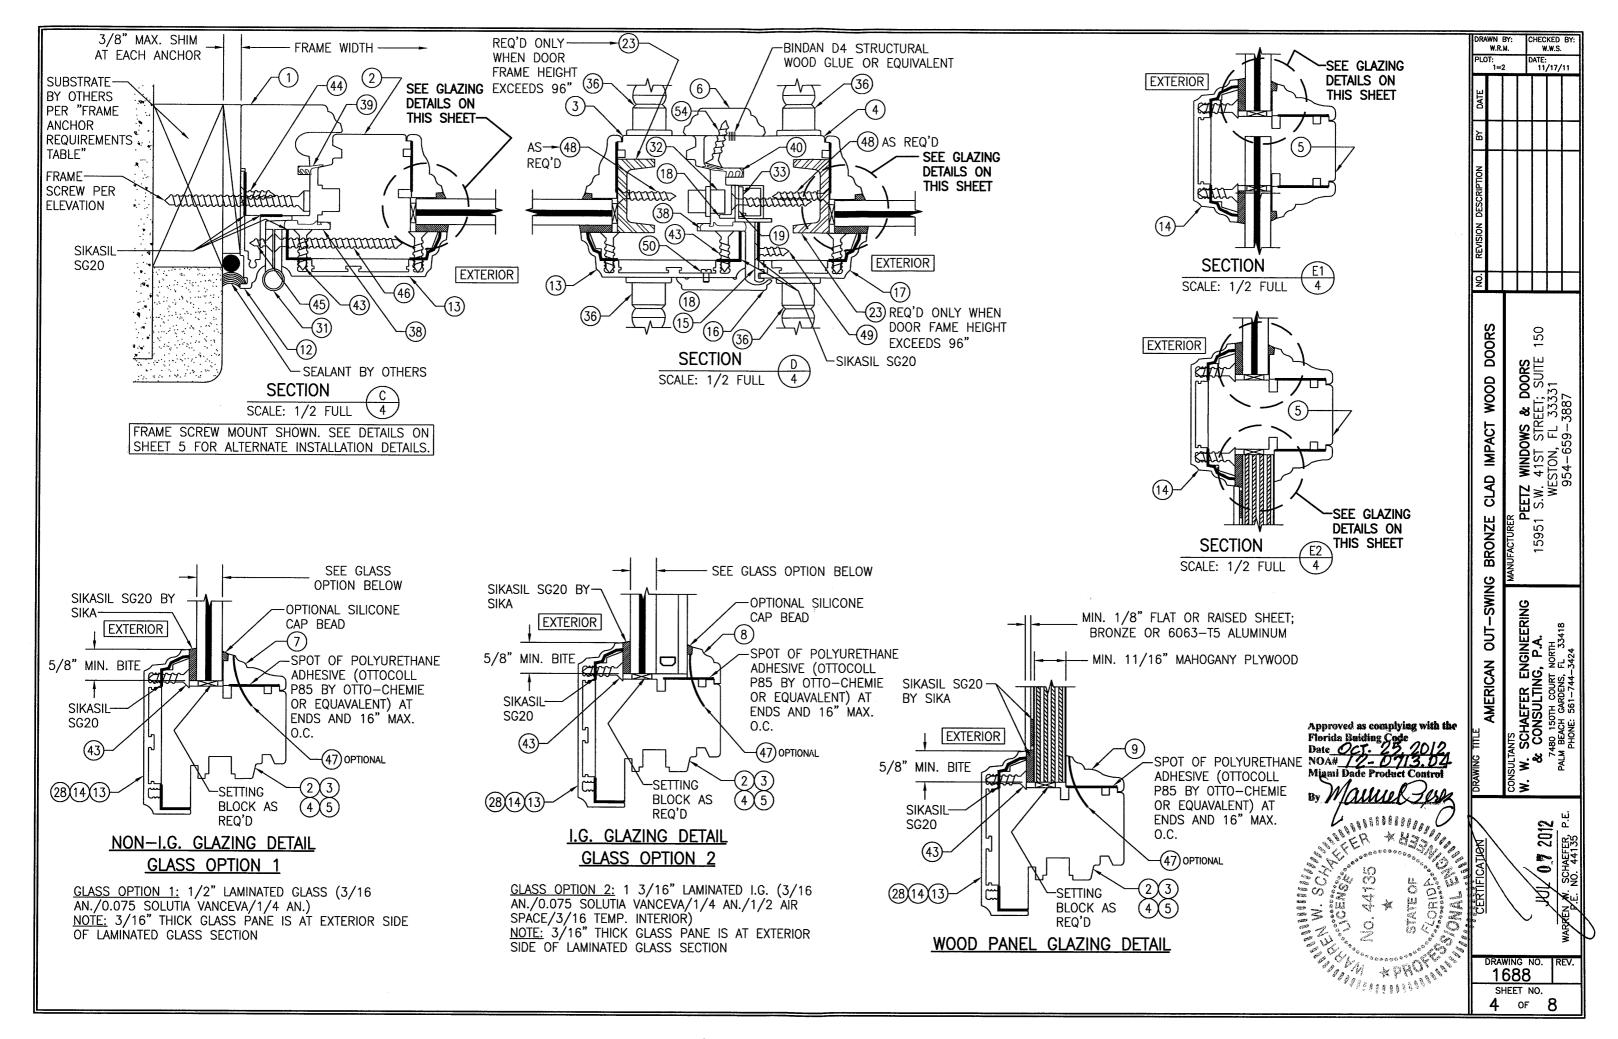

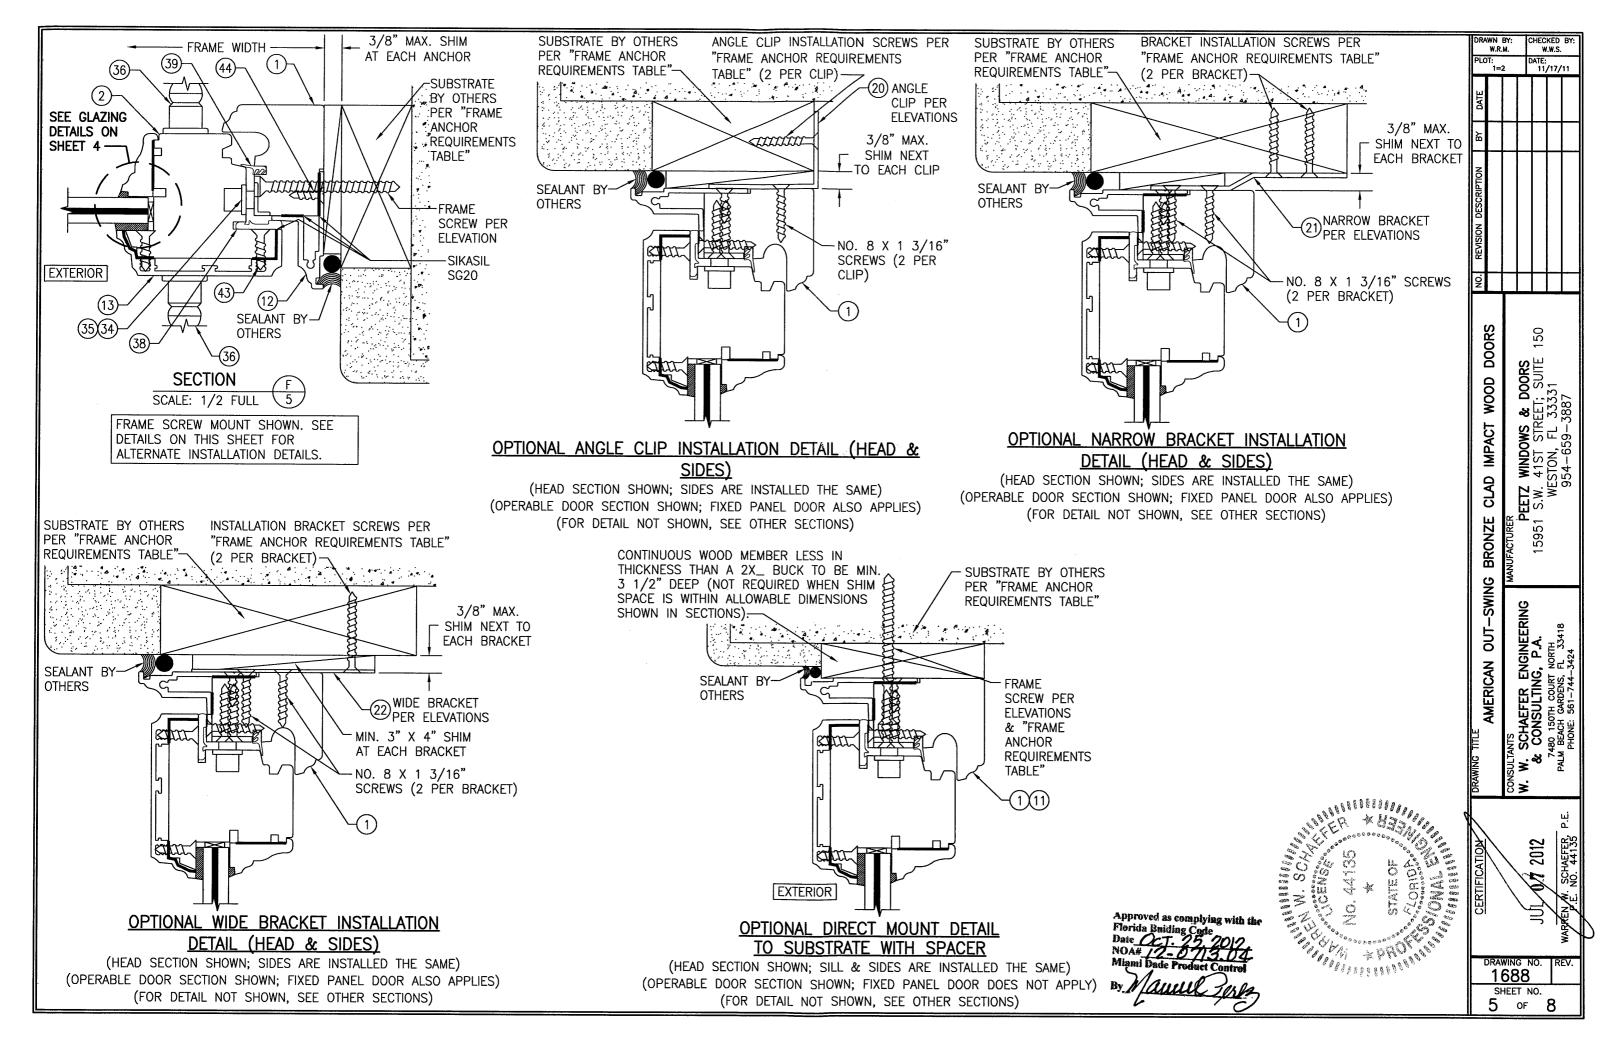

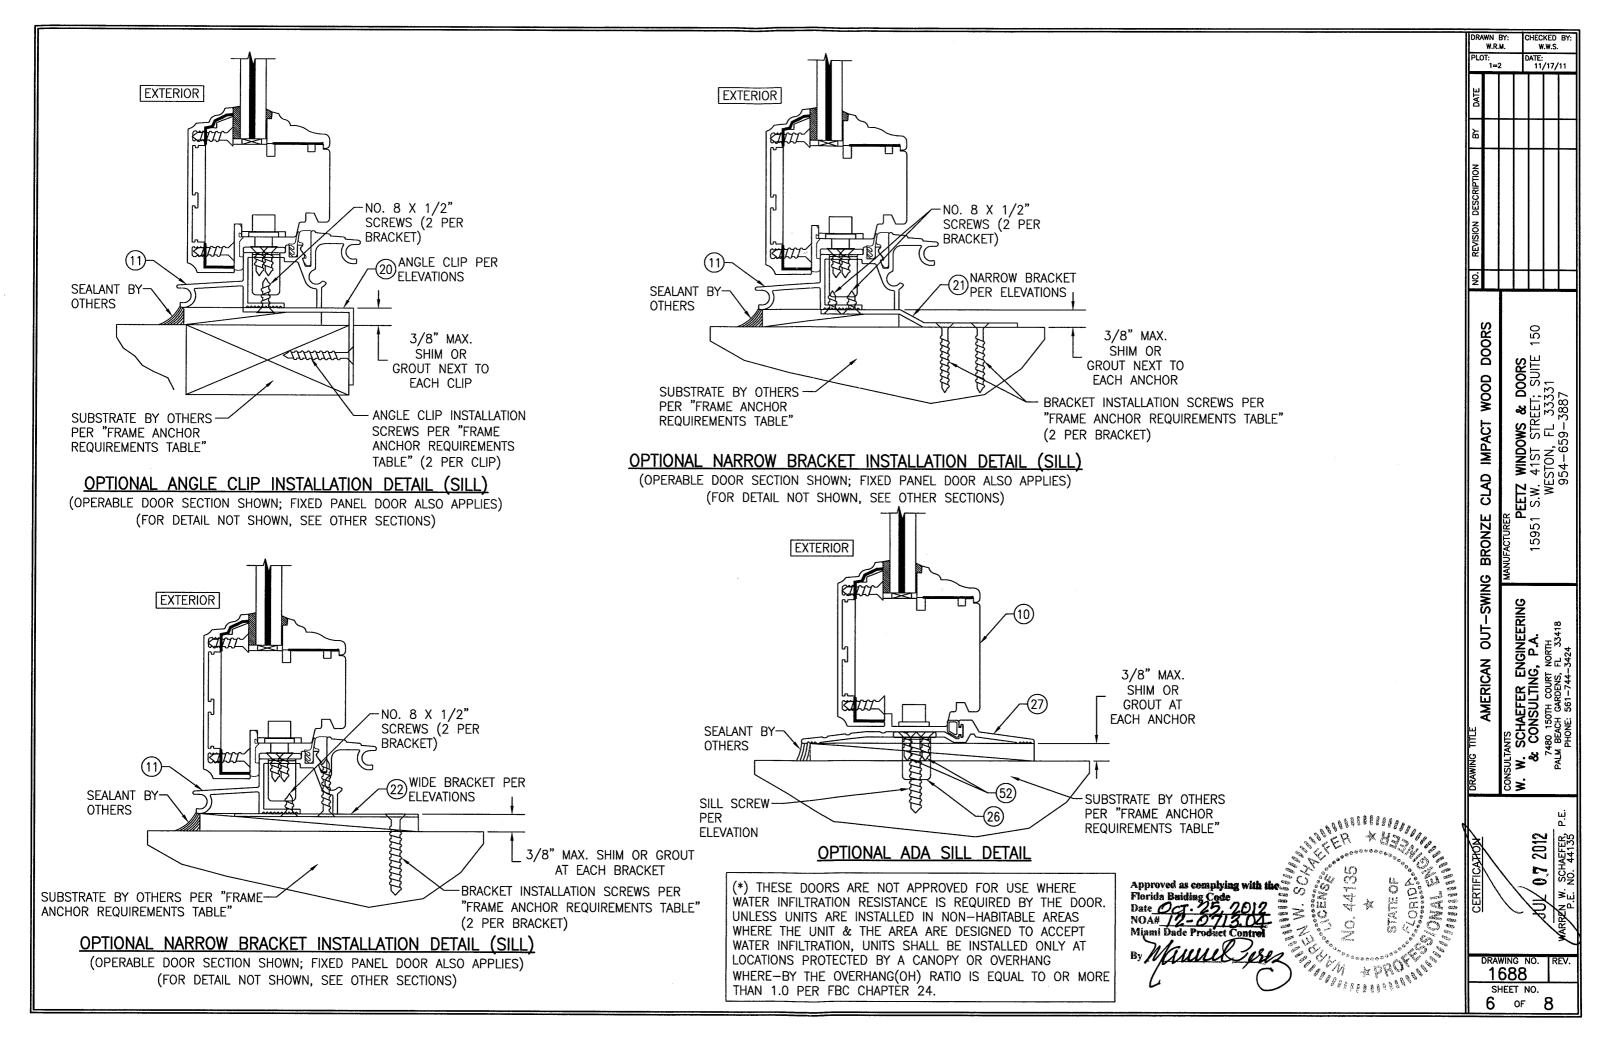

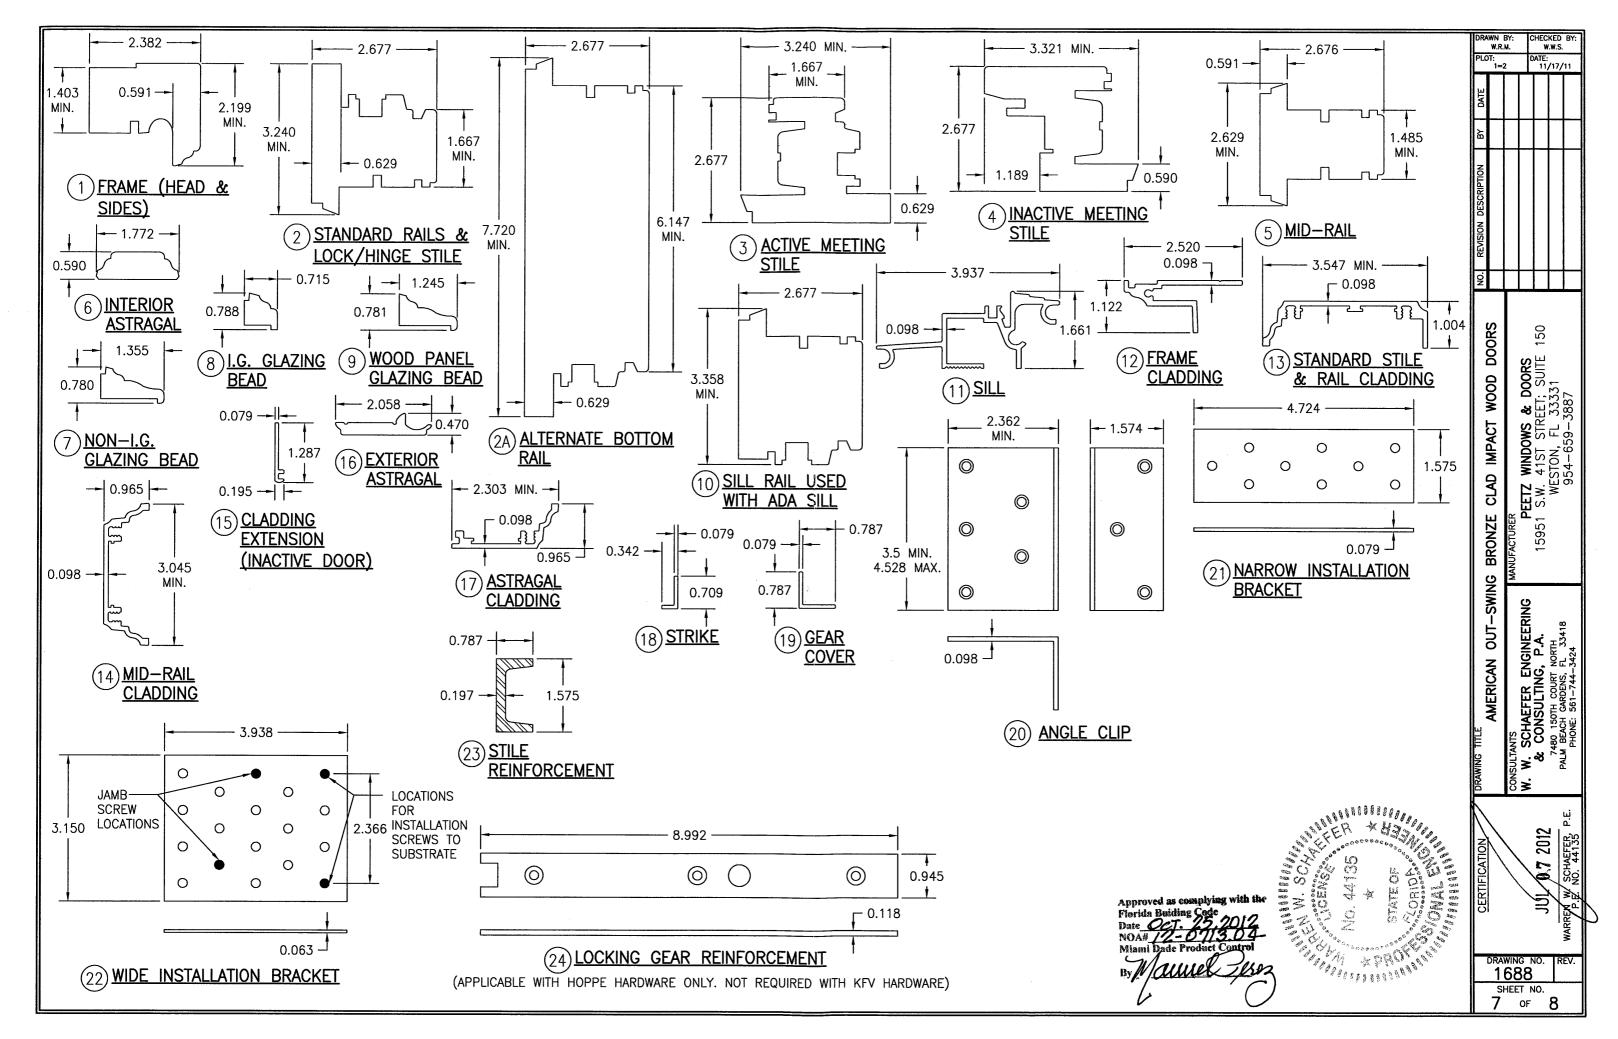

| ITEM # | | MANUFACTURER/NOTES | |
|--------|--|--------------------------------------|--|
| | PARTS | | |
| 1 | FRAME (HEAD & SIDES) | WOOD | |
| 2 | STANDARD RAILS (SILL RAIL USED WITH STANDARD SILL) | WOOD | |
| | & LOCK/HINGE STILE | | |
| _2A | ALTERNATE BOTTOM RAIL | WOOD | |
| 3 | ACTIVE MEETING STILE | WOOD | |
| 4 | INACTIVE MEETING STILE | WOOD | |
| 5 | MID-RAIL | WOOD | |
| 6 | INTERIOR ASTRAGAL | WOOD | |
| 7 | NON-I.G. GLAZING BEAD | WOOD | |
| 8 | I.G. GLAZING BEAD | WOOD | |
| 9 | WOOD PANEL GLAZING BEAD | WOOD | |
| 10 | SILL RAIL USED WITH ADA SILL | WOOD | |
| 11 | SILL | BRONZE OR 6063-T5 ALUMINUM | |
| 12 | FRAME CLADDING | BRONZE OR 6063-T5 ALUMINUM | |
| 13 | STANDARD STILE & RAIL CLADDING | BRONZE OR 6063-T5 ALUMINUM | |
| 14 | MID-RAIL CLADDING | BRONZE OR 6063-T5 ALUMINUM | |
| 15 | SASH CLADDING EXTENSION (INACTIVE DOOR) | BRONZE OR 6063-T5 ALUMINUM | |
| 16 | EXTERIOR CLADDING | BRONZE OR 6063-T5 ALUMINUM | |
| 17 | ASTRAGAL CLADDING | BRONZE OR 6063-T5 ALUMINUM | |
| 18 | STRIKE | BRONZE OR 6063-T5 ALUMINUM | |
| 19 | GEAR COVER | BRONZE OR 6063-T5 ALUMINUM | |
| 20 | ANGLE CLIP | GALVANIZED 34 KSI STEEL | |
| 21 | NARROW INSTALLATION BRACKET | GALVANIZED 34 KSI STEEL | |
| 22 | WIDE INSTALLATION BRACKET | GALVANIZED 34 KSI STEEL | |
| 23 | STILE REINFORCEMENT | GALVANIZED 34 KSI STEEL | |
| | | REQ'D ONLY WHEN DOOR FRAME HEIGHT | |
| | | EXCEEDS 96" | |
| 24 | LOCKING GEAR REINFORCEMENT | S.S. BY PEETZ | |
| | | REQ'D ONLY WITH HOPPE LOCK SYSTEM | |
| 25 | TOP LOCK STRIKE | S.S. BY PEETZ | |
| 26 | BOTTOM LOCK STRIKE | S.S. OR BRONZE BY PEETZ | |
| 27 | ADA THRESHOLD | 2005 PEMKO BRONZE | |
| 28 | ALTERNATE BOTTOM RAIL CLADDING | BRONZE OR 6063-T5 ALUMINUM | |
| 29 | ALTERNATE BOTTOM RAIL CLADDING EXTENSION | BRONZE OR 6063-T5 ALUMINUM | |
| | HARDWARE | | |
| 31 | BUTT HINGE 8 9/16" LONG | BRASS, PLATED STEEL, OR S.S. BY BROS | |
| 32 | 5 POINT MULTI-POINT LOCK SYSTEM | BY: KFK OR HOPPE | |
| | AT ACTIVE PANEL (DOUBLE DOOR CONDITION) | TYPE: ROLLERBOLT/SHOOTBOLT/DEADBOLT | |
| 33 | 2 POINT MULTI-POINT LOCK SYSTEM | BY: KFV OR HOPPE | |
| | AT INACTIVE PANEL | TYPE: SHOOTBOLT | |
| 34 | 4 POINT MULTI-POINT LOCK SYSTEM | BY: KFV OR HOPPE | |
| | (SINGLE DOOR; ALL HEIGHTS) | TYPE: SHOOTBOLT/DEADBOLT | |
| 35 | 3 POINT MULTI-POINT LOCK SYSTEM | BY: HOPPE | |
| | (SINGLE DOOR WITH LESS THAN 120" FRAME HEIGHT) | TYPE: SHOOTBOLT/DEADBOLT | |
| 36 | HANDLE | AS REQUIRED TO OPERATE LOCK SYSTEM | |
| | SEALS & SEALANTS | | |
| 38 | COMPRESSION SEAL | SCHLEGEL QL3097 URETHANE | |
| 39 | WEATHERSTRIP | GTG EPDM | |
| 40 | WEATHERSTRIP | HAUTAU EPDM HD25 | |
| 41 | COMPRESSION SEAL | SCHLEGEL QL3063 URETHANE | |

| ITEM # | ITEM DESCRIPTION | MANUFACTURER/NOTES |
|-----------|---|--|
| FASTENERS | | |
| 43 | 3/16" X 7/8" SELF TAPPING SCREW | WITHIN 5" OF CORNERS & 13 1/2" MAX. O.C. |
| 44 | NO. 8 X 13/16" SMS SCREW | WITHIN 5" OF CORNERS & 15" MAX. O.C. |
| 45 | M5 X 15mm SELF TAPPING SCREW | 6 PER HINGE INTO FRAME CLADDING |
| 46 | 3/16" X 2 3/4" WOOD SCREW | 6 PER HINGE INTO SASH |
| 47 | 18 GA. X 1 1/4" GALV. CURVED NAIL | WITHIN 10" OF CORNERS & 20" MAX. O.C. |
| 48 | NO. 8 X 1 3/8" WOOD SCREW | WITHIN 6" OF CORNERS & 14" MAX. O.C. |
| 49 | NO. 8 X 13/16" WOOD SCREW | WITHIN 2" OF ENDS & 12" MAX. O.C. |
| 50 | M5 X 8mm MACHINE SCREW | WITHIN 2" OF CORNERS & 9 1/2" MAX. O.C. |
| 51 | 3/16" X 1 3/8" WOOD SCREW | 5 PER TOP STRIKE PLATE |
| 52 | M5 X 15mm MACHINE SCREW | 4 PER BOTTOM STRIKE PLATE |
| | .295" X 3 1/4" AMO III GALVANIZED STEEL SCREW | WITHIN 5 1/2" OF CORNERS & 14" MAX. O.C. |
| 54 | NO. 8 X 1" WOOD SCREW | WITHIN 1" OF ENDS & 8" MAX. O.C. |

CHECKED BY: W.W.S. DATE: 11/17/11

1=2

WOOD DOORS

CLAD IMPACT

BRONZE

OUT-SWING

AMERICAN

2012


DRAWING NO. SHEET NO.

8 of

8

DOORS I; SUITE 331

NOTE: WOOD USED IN TESTING WAS MAHOGANY WITH A SPECIFIC GRAVITY OF G=0.46 AND A MODULUS OF ELASTICITY OF E = 1,500,000 PSI. OTHER WOOD SPECIES APPLICABLE FOR USE WITH THIS PRODUCT ARE THOSE WITH A SPECIFIC GRAVITY OF 0.46 AND MODULUS OF ELASTICITY OF 1,500,000 PSI OR GREATER. ALL WOOD IS MINIMUM GRADE 2 MILLED BY PEETZ WINDOWS & DOORS TO SELECT.

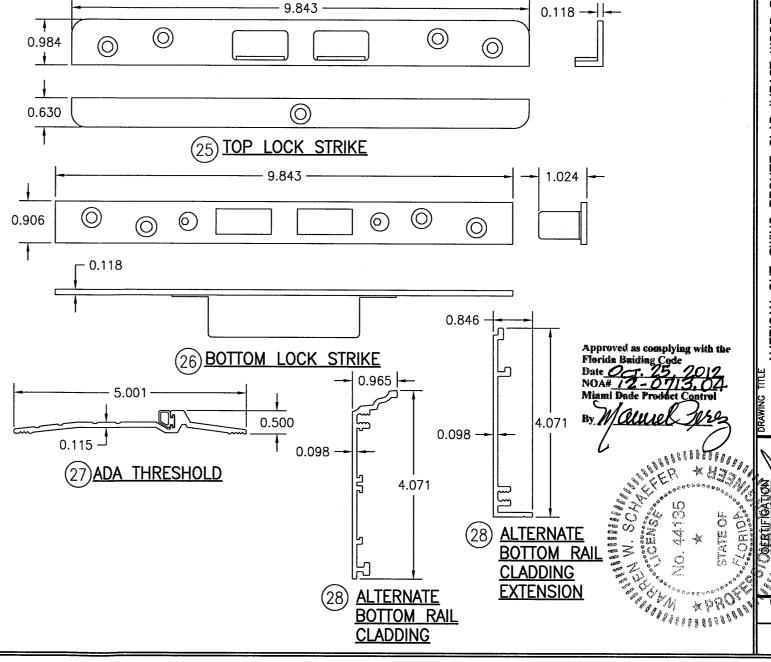

CLADDING